

SITE LOCATION PLAN

SCALE 1:50000

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PHOTOGRAPH PROPOSED SITE/EQUIPMENT LOCATION

0	500	1000	1500	2000	2500m
	L	INEAR SC	ALE 1:5000	00	

E451170 N198297

OPTION NUMBER

NOTES:

- 1. DO NOT SCALE
- 2. ALL PROPOSED WORKS SHOWN GREEN AND TEXT BOXED
- 3. SITE DESIGN CONFORMS TO EEL / MBNL DOCUMENT: STANDARD ICNIRP DESIGN RD10102 / GSDD008 Ver 8.0

Α	FIRST ISSUE	MB	04.12.2017
REV	DESCRIPTION OF REVISION	BY	DATE

COLOUR CHART (REPRESENTS PROPOSED WORK AND NOT THE ACTUA

BLACK TEXT & EXISTING BUILDINGS, STRUCTURES, MASTS, TREES, EEL & OTHER OPERATORS EQUIPMENT GREEN PROPOSED INSTALLATION

BLUE PROPOSED VEHICULAR ACCESS PROPOSED PEDESTRIAN ACCESS YELLOW ___





PLANNING

RADLEY ROAD SW

GRASS VERGE ON RADLEY RD RADLEY ROAD **ABINGDON** 0X14 3SL

EE CELL ID	OUK CELL ID	H3G CELL ID	MBNL CELL ID
93283	-	-	VWH101

SITE LOCATION MAPS

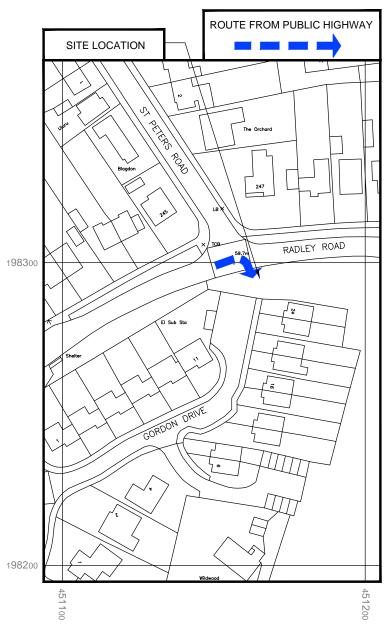
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S SHOWN	MB	29.11.2017	WP	04		
WHEN PRINTED AT A3		IONS IN mm UN				

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SITE ACCESS PLAN

SCALE 1:1250

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OPTION NUMBER

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4	FIRST ISSUE	MB	04.12.2017
ΕV	DESCRIPTION OF REVISION	BY	DATE

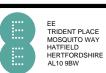
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PURPOSE OF ISSUE

PLANNING

SITE NAME

RADLEY ROAD SW

SITE ADDRESS

GRASS VERGE ON RADLEY RD RADLEY ROAD ABINGDON 0X14 3SL

EE CELL ID	OUK CELL ID	H3G CELL ID	MBNL CELL II
93283	-	-	VWH10

RAWING TITLE

SITE ACCESS PLAN

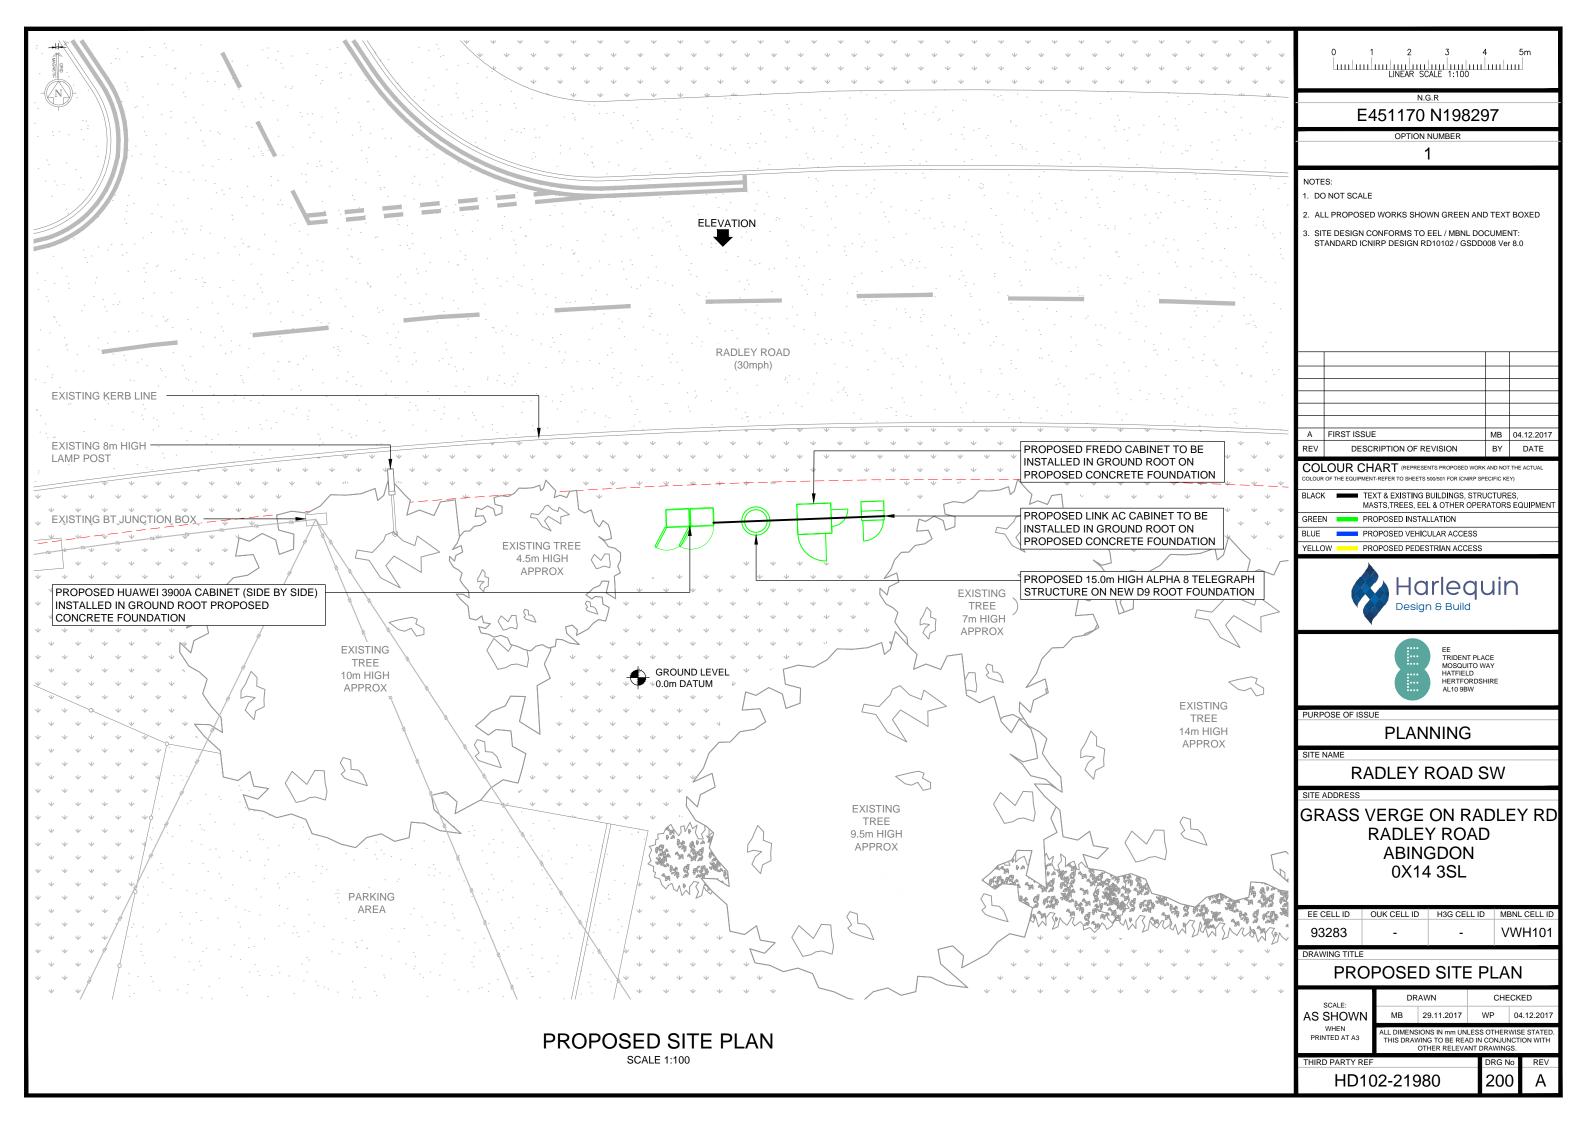
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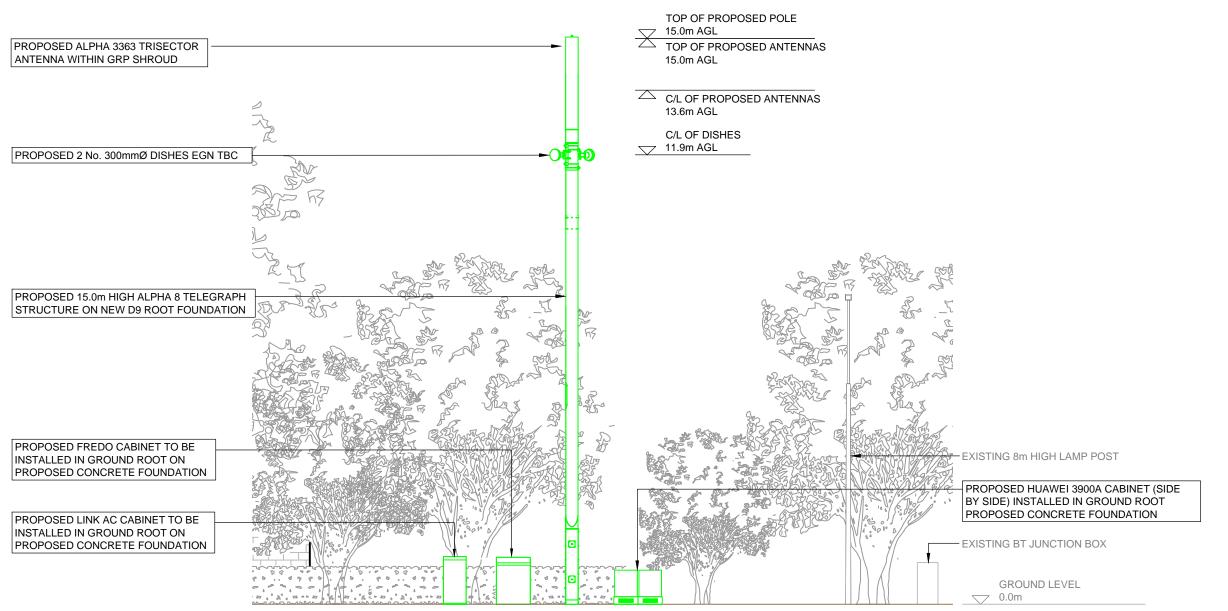
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TOWER DE	ETAILS:		TOWER SUPPLIER: HUTCHINSON ENG.		
CODE: HEIGHT:		TOWER DESCRIPTION:	COLOUR REF:		
-	15.0m	ALPHA 8 STREETPOLE	BLACK BROWN (RAL8022)		
CUSTOM:	•	CUSTOM COMMENT:			
N NA					
ANTENNA	DETAILS:	•	COLOUR REF:		
ALPHA 336	3 TRISECTOR AI	NTENNA & 2No. DISHES	STANDARD		
CABINET D	DETAILS:		COLOUR REF:		
FREDO CABINET			FIR GREEN (RAL6009)		
HUAWEI 3900A CABINET (SIDE BY SIDE)			FIR GREEN (RAL6009)		
LINK AC			FIR GREEN (RAL6009)		



N.G.R E451170 N198297

OPTION NUMBER

4

LINEAR SCALE 1:100

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PURPOSE OF ISSUE

PLANNING

SITE NAME

RADLEY ROAD SW

SITE ADDRES

GRASS VERGE ON RADLEY RD RADLEY ROAD ABINGDON 0X14 3SL

93283 - H3G CELL ID MBNL CELL ID VWH101

DRAWING TITLE

PROPOSED SITE ELEVATION

SCALE:
AS SHOWN
WHEN
PRINTED AT A3

DRAWN CHECKED

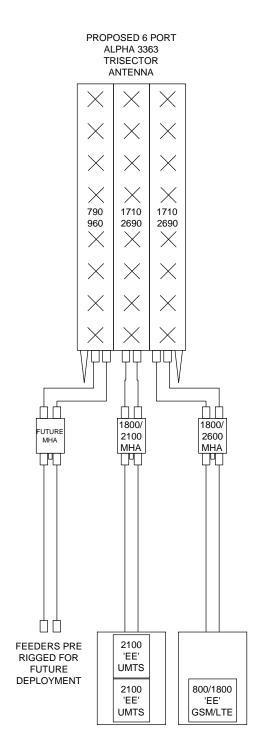
MB 29.11.2017 WP 04.12.201

ILL DIMENSIONS IN mm UNLESS OTHERWISE STATE
THIS DRAWING TO BE READ IN CONJUNCTION WITH
OTHER RELEVANT DRAWINGS.

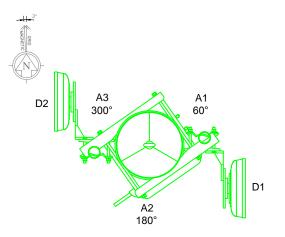
HIRD PARTY REF
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PROPOSED NORTH ELEVATION



ANTENNA SCHEMATIC



HEADFRAME PLAN @ 15.0m AGL SCALE 1:25

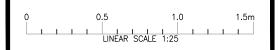
ANTENNA LINE KEY														
	ANTEN	INA TYPE AND PO		TILT		ANTENNA ALLOCA		MHA REF	RI	ĒΤ	С	VERALL SY	STEM LOS	S
SECTOR ID	ANTENNA TYPE	ANTENNA C/L (m) AGL	BEARING (°)	MECHANICAL TILT (°)	PORT FREQUENCY RANGE	OPERATING FREQUENCY	RFU/ RRU	MHA NAME	RET CABLE LOCATION	RET NAME	ANT JUMPER LENGTH (m) AND TYPE	MAIN FEEDER LENGTH (m) AND TYPE	BTS TAIL LENGTH (m) AND TYPE	ESTIMATED TOTAL LOSS (dB)
A1	ALPHA 3363 TRISECTOR ANTENNA	13.6m	60° EGN	0	790-2690	800/1800/ 2100	RFU	RADIO DESIGN RD0433 1800/2100 DDLNA RADIO DESIGN RD0448-02 1800/2100 DDLNA	HUAWEI 3900A FREDO	-	1m LCF12-50	16m LCF78-50	2m LCF12-50	PROPOSED
A2	ALPHA 3363 TRISECTOR ANTENNA	13.6m	180° EGN	0	790-2690	800/1800/ 2100	RFU	RADIO DESIGN RD0433 1800/2100 DDLNA RADIO DESIGN RD0448-02 1800/2100 DDLNA	HUAWEI 3900A FREDO	-	1m LCF12-50	16m LCF78-50	2m LCF12-50	PROPOSED
А3	ALPHA 3363 TRISECTOR ANTENNA	13.6m	300° EGN	0	790-2690	800/1800/ 2100	RFU	RADIO DESIGN RD0433 1800/2100 DDLNA RADIO DESIGN RD0448-02 1800/2100 DDLNA	HUAWEI 3900A FREDO	-	1m LCF12-50	16m LCF78-50	2m LCF12-50	PROPOSED

NOTE: INFORMATION HELD ON INS TAKES PRECEDENCE OVER ALL KEYS AND SCHEDULES SHOWN

	PROPOSED EEL EQUIPMENT SCHEDULE							
ITEM	TYPE	SIZE (mm) (HxWxD)	OTHER INFO.	COMMENTS				
IT-1	LINK AC	1520x600x500	-	PROPOSED				
IT-2	HUAWEI 3900A	900x1200x480	SIDE BY SIDE	PROPOSED				
IT-3	FREDO	1240x900x800	-	PROPOSED				

		PROPOSED EEL DISH KEY								
	DISH REF	DISH DIA.	AZIMUTH (EGN)	HEIGHT TO CENTRE (AGL)	REMOTE RFU? (Y/N)	FUNCTION LINK No.	COMMENTS			
1	D1	300mm	TBC°	11.9m	N	твс	PROPOSED			
	D2	300mm	TBC°	11.9m	N	TBC	PROPOSED			

EEL POWER REQUIREMENT - PROPOSED 21kVA SINGLE PHASE SUPPLY (DNO)



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